

August 1, 2016 Item #4

SEDIMENTATION AND EROSION CONTROL NOTES

MAINTENANCE PROCEDURES FOR TEMPORARY SEDIMENTATION AND EROSION CONTROL DEVICES
 At the completion of construction, the contractor shall maintain the sedimentation and erosion control devices in good working order until the site is stabilized. The contractor shall remove and dispose of all sedimentation and erosion control devices in a timely manner. The contractor shall be responsible for the removal and disposal of all sedimentation and erosion control devices. The contractor shall be responsible for the removal and disposal of all sedimentation and erosion control devices. The contractor shall be responsible for the removal and disposal of all sedimentation and erosion control devices.

SEQUENCE OF CONSTRUCTION

1. INSTALL/REMOVE SILT FENCE.
2. EXCAVATE FOOTINGS FOR NEW WALL CONSTRUCTION.
3. CONSTRUCT NEW RETAINING WALL.
4. BACKFILL WALL, PROVIDE DRAIN IN CHASED STEPS.
5. RELOCATE EXISTING SILT FENCE.
6. RELOCATE EXISTING SILT FENCE.
7. RELOCATE EXISTING SILT FENCE.
8. REMOVE SILT FENCE.
9. REMOVE SILT FENCE.
10. REMOVE SILT FENCE.

APPROXIMATE AMOUNT OF FILL TO BE PLACED FOR CONSTRUCTION OF NEW WALL=48 CY

GENERAL

This project requires erosion control measures to adequately control sedimentation and erosion. The contractor shall be responsible for the implementation, maintenance, and removal of all sedimentation and erosion control devices. The contractor shall be responsible for the implementation, maintenance, and removal of all sedimentation and erosion control devices. The contractor shall be responsible for the implementation, maintenance, and removal of all sedimentation and erosion control devices.

SEDIMENTATION CONTROL

All areas shall be protected from sedimentation during and after construction. The contractor shall be responsible for the implementation, maintenance, and removal of all sedimentation and erosion control devices. The contractor shall be responsible for the implementation, maintenance, and removal of all sedimentation and erosion control devices. The contractor shall be responsible for the implementation, maintenance, and removal of all sedimentation and erosion control devices.

EROSION AND SEDIMENTATION CONTROL PLAN

The erosion and sedimentation control system shall be designed to prevent erosion and sedimentation during and after construction. The contractor shall be responsible for the implementation, maintenance, and removal of all sedimentation and erosion control devices. The contractor shall be responsible for the implementation, maintenance, and removal of all sedimentation and erosion control devices. The contractor shall be responsible for the implementation, maintenance, and removal of all sedimentation and erosion control devices.



REFERENCE MAP


TOWN OF WEST HARTFORD, CONNECTICUT, ZONING MAP, SECTION 1, HUNTER DRIVE, WEST HARTFORD, CONNECTICUT, MAP NO. 21, 1952, 1-4-62, GEORGE R. JENNISON, CIVIL ENGINEER, HUNTER DRIVE, WEST HARTFORD, CT. REVISED HUNTER DRIVE MAY 16, 1959.

NOTES:

1. THIS SURVEY HAS BEEN PREPARED PURSUANT TO THE REGULATIONS OF THE STATE DEPARTMENT OF CONSTRUCTION, DIVISION OF SURVEYING, AND THE CONSTRUCTION ASSOCIATION OF LAND SURVEYORS, INC. ON SEPTEMBER 28, 1986.
2. THE SURVEY IS A GENERAL LOCATION SURVEY.
3. BOUNDARY DETERMINATION BY OTHER DEPENDENT RESURVEY.
4. CLASS OF SURVEYING ACCURACY: 4-2.
5. CLASS OF TOPOGRAPHIC ACCURACY: 7-3.
6. METHOD USED: RETICULAR APPLICATION PLAN.
7. HORIZONTAL DATA IS BASED UPON NAD83 DATUM.
8. THIS MAP IS VALID ONLY IF IT BEARS THE ORIGINAL SURVEYOR AND ENGINEER SEAL OF THE PROFESSIONAL LAND SURVEYOR.
9. TO MY KNOWLEDGE AND BELIEF, THIS MAP IS SUBSTANTIALLY CORRECT AS NOTED HEREIN.




SURVEYOR'S SIGNATURE	DATE	LICENSE NUMBER
	10/28/16	

1814-142 TDWG 16144

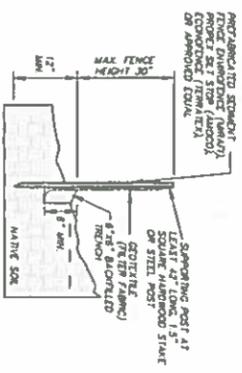

SEDIMENTATION CONTROL SYSTEM INSTALLATION
 NO SCALE

PROPOSED RETAINING WALL DETAIL

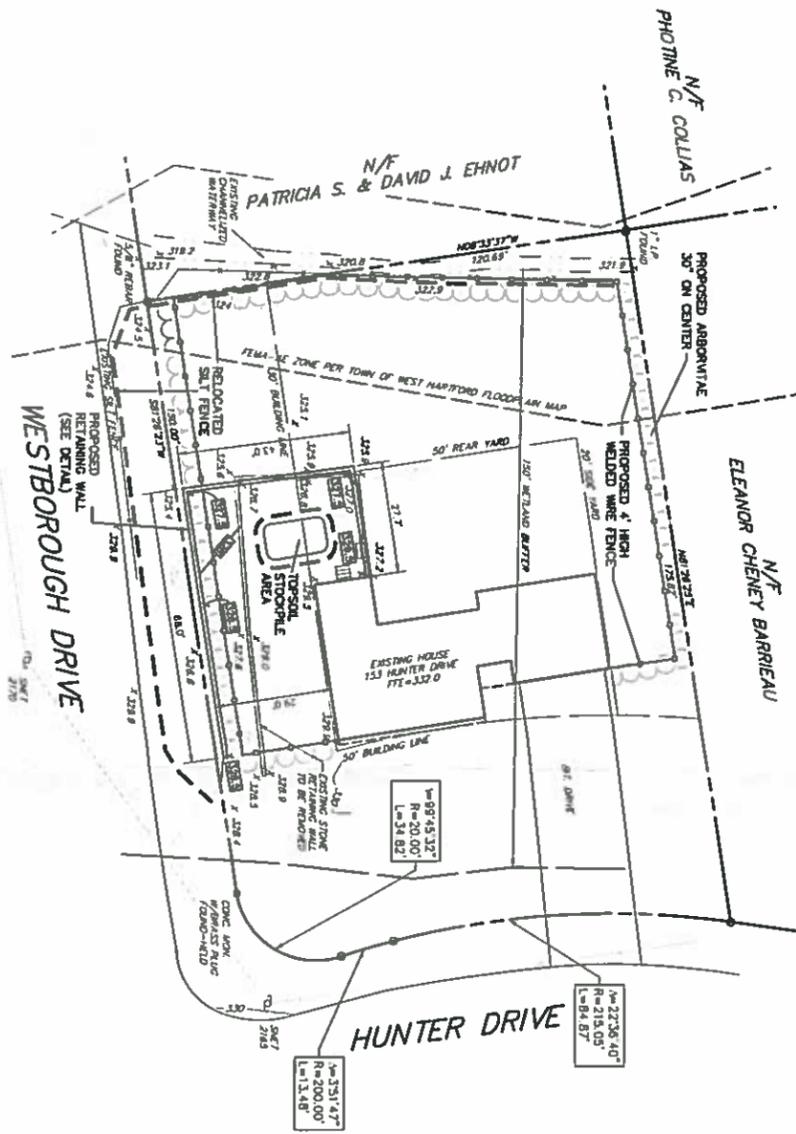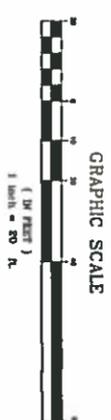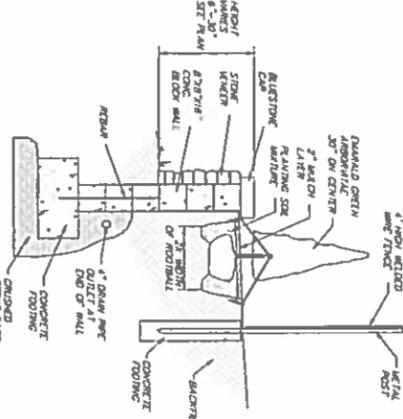

LEGEND

	PROPERTY LINE
	BOUNDARY LINE
	PROPOSED RETAINING WALL
	SEDIMENTATION CONTROL SYSTEM
	EXISTING RETAINING WALL
	PROPOSED SLOPE
	EXISTING SLOPE
	UTILITY POLE

THIS DRAWING HAS BEEN PREPARED BASED ON AVAILABLE DATA. THE SURVEYOR HAS CONDUCTED A VISUAL INSPECTION OF THE SITE AND HAS FOUND THE DATA TO BE SUFFICIENT FOR THE PURPOSES OF THIS SURVEY. THE SURVEYOR IS NOT RESPONSIBLE FOR ANY ERRORS OR OMISSIONS WHICH MAY OCCUR AS A RESULT OF THIS SURVEY. THE SURVEYOR IS NOT RESPONSIBLE FOR ANY ERRORS OR OMISSIONS WHICH MAY OCCUR AS A RESULT OF THIS SURVEY. THE SURVEYOR IS NOT RESPONSIBLE FOR ANY ERRORS OR OMISSIONS WHICH MAY OCCUR AS A RESULT OF THIS SURVEY.

<p>IMPROVEMENT LOCATION SURVEY</p>	<p>WETLAND APPLICATION PLAN PREPARED FOR</p> <p>NORMAN W. ABARE, JR.</p> <p>153 HUNTER DRIVE WEST HARTFORD, CONNECTICUT</p>	<p>Date: 07-20-16 Drawn: D.D.</p>	<p>Scale: 1"=20' Checked: AB</p>	<p>THE BONDYARD GROUP, INC. 170 Pine Road Newington, Conn. 06111 TEL (860) 666-0134 FAX (860) 666-3630</p>		
	<p>1</p>	<p>1</p>	<table border="1"> <thead> <tr> <th>Revision</th> <th>Date</th> </tr> </thead> <tbody> <tr> <td></td> <td></td> </tr> </tbody> </table> <p>WALL, FENCE AND PLANTINGS 07-27-16</p>		Revision	Date
Revision	Date					